
# Civil Exhibits



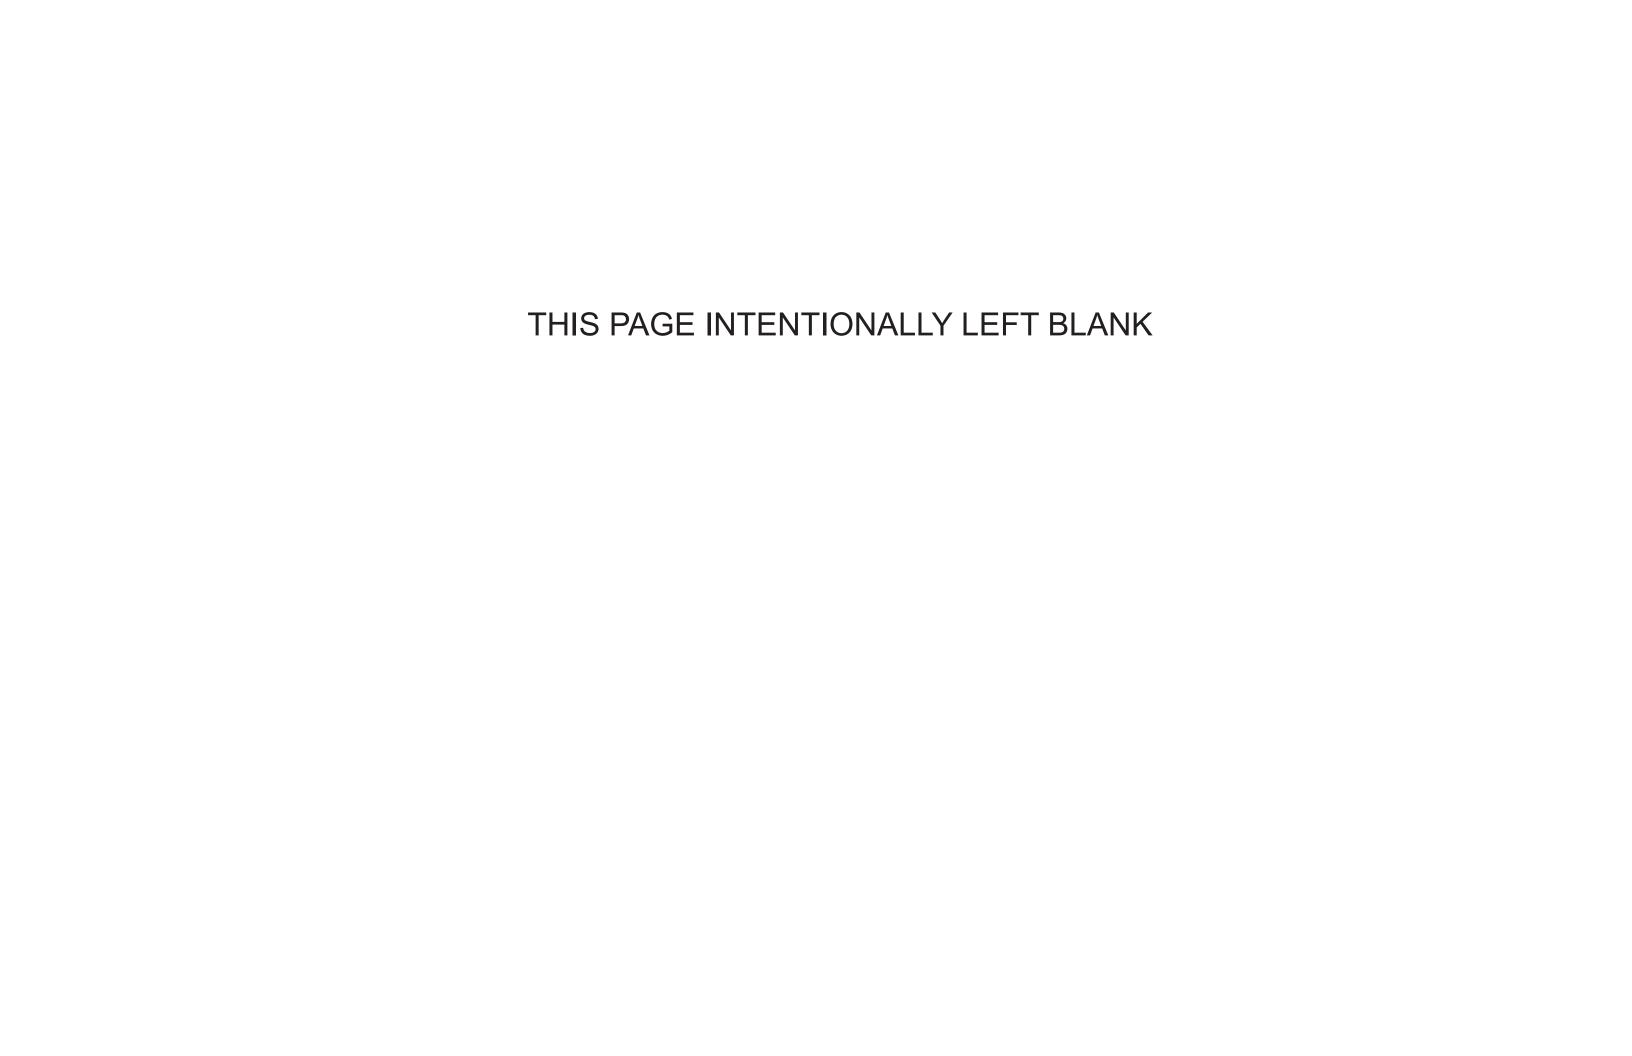



#### STANDARD DRAWING LEGEND

FOR ENTIRE PLAN SET (NOT TO SCALE)

	1	(NOT TO	OOALL)		
EXISTING NOTE	TYPICAL NOTE TEXT	PROPOSED NOTE	EXISTING NOTE	TYPICAL NOTE TEXT	PROPOSED NOTE
	ONSITE PROPERTY LINE / R.O.W. LINE		OH	OVERHEAD WIRE	———ОН
	NEIGHBORING PROPERTY LINE / INTERIOR PARCEL LINE			UNDERGROUND TELEPHONE LINE	тт
	EASEMENT LINE		c	UNDERGROUND CABLE LINE	с
	SETBACK LINE		======	STORM SEWER	
			S	SANITARY SEWER MAIN	s
		CURB AND GUTTER	8	HYDRANT	$\nabla$
	CONCRETE CURB & GUTTER	SPILL CURB TRANSITION CUR	<b>S</b>	SANITARY MANHOLE	<b>(6)</b>
		DEPRESSED CURB AND GUTTE	(D)	STORM MANHOLE	<b>(</b>
+ ===	UTILITY POLE WITH LIGHT		⊗ <sup>WM</sup>	WATER METER	•
E	POLE LIGHT	<b></b>	₩V	WATER VALVE	•
n€	TRAFFIC LIGHT	<b>⊙</b> €		GAS VALVE	
0	UTILITY POLE	0	$\boxtimes$	GAS METER	$\boxtimes$
	TYPICAL LIGHT	<u> </u>	Δ	TYPICAL END SECTION	Δ
ф	ACORN LIGHT	ф		HEADWALL OR ENDWALL	Jor
	TYPICAL SIGN	<del></del>	( )	YARD INLET	<b>(III)</b>
$\triangle$	PARKING COUNTS	$\triangle$	<u>©</u>	CURB INLET	<b>©</b> ")
			0	CLEAN OUT	0
——————————————————————————————————————	CONTOUR LINE	<u>190</u> 187	Ē	ELECTRIC MANHOLE	E
TC 516.4 OR 516.4	SPOT ELEVATIONS	TC 516.00 BC 515.55	7	TELEPHONE MANHOLE	T
	ı		EB	ELECTRIC BOX	EB
SAN #	SANITARY LABEL	SAN #	F	ELECTRIC PEDESTAL	EP
X #	STORM LABEL	X #		MONITORING WELL	
St	SANITARY SEWER LATERAL			TEST PIT	<b>‡</b>
	UNDERGROUND WATER LINE			BENCHMARK	
E	UNDERGROUND ELECTRIC LINE	——Е——	<b>•</b>	BORING	<b>•</b>
	UNDERGROUND GAS LINE				

#### **GENERAL NOTES:**

- 1. THE PLAN IS BASED ON THE FOLLOWING DOCUMENTS AND INFORMATION
  - ENTITLED: "ALTA/ACSM LAND TITLE SURVEY, THE HANOVER COMPANY, LOT 15, SQUARE 3382 AND A&T LOT 804, SQUARE 3835, 3201 & 3135 8TH STREET NE, DISTRICT OF COLUMBIA", PREPARED BY: BOHLER ENGINEERING, PROJECT NUMBER: SRW182079, DATED: 08/19/18
  - DIGITAL ARCHITECTURAL PLANS: ENTITLED: "180430 BROOKLAND RESIDENTIAL APARTMENTS -SP1\_2018 v22.DWG" PREPARED BY: KGTY ARCHITECTS, DATE RECEIVED: 10/12/18
- 2. LOCATION OF ALL UNDERGROUND UTILITIES ARE APPROXIMATE. ALL LOCATIONS AND SIZES ARE BASED ON UTILITY MARK OUTS, ABOVE GROUND STRUCTURES THAT WERE VISIBLE & ACCESSIBLE IN THE FIELD, AND THE MAPS AS LISTED IN THE REFERENCES AVAILABLE AT THE TIME OF THE SURVEY. AVAILABLE AS-BUILT PLANS AND UTILITY MARK OUT DOES NOT ENSURE MAPPING OF ALL UNDERGROUND UTILITIES AND STRUCTURES. BEFORE ANY EXCAVATION IS TO BEGIN, ALL UNDERGROUND UTILITIES SHOULD BE VERIFIED AS TO THEIR LOCATION, SIZE, AND TYPE BY THE PROPER UTILITY COMPANIES.

SHEET INDEX					
SHEET TITLE	SHEET NUMBER				
GENERAL NOTES AND LEGEND	C-101				
EXISTING CONDITIONS PLAN	C-201				
SITE PLAN	C-301				
GRADING PLAN	C-401				
UTILITY PLAN	C-501				
EROSION AND SEDIMENT CONTROL PLAN	C-601				
EROSION AND SEDIMENT CONTROL PLAN NOTES AND DETAILS	C-602				
PUBLIC SPACE PLAN	C-701-702				
VEHICULAR TURNING MOVEMENTS (BY OTHERS)	C-801				
STORMWATER MANAGEMENT PLAN	C-901-902				
STORMWATER MANAGEMENT CALCULATIONS AND DETAILS	C-904				


#### DEVELOPER

THE HANOVER COMPANY CORPORATE OFFICE 5847 SAN FELIPE, SUITE 3600 HOUSTON, TX 77057


#### **GENERAL NOTES AND LEGEND**






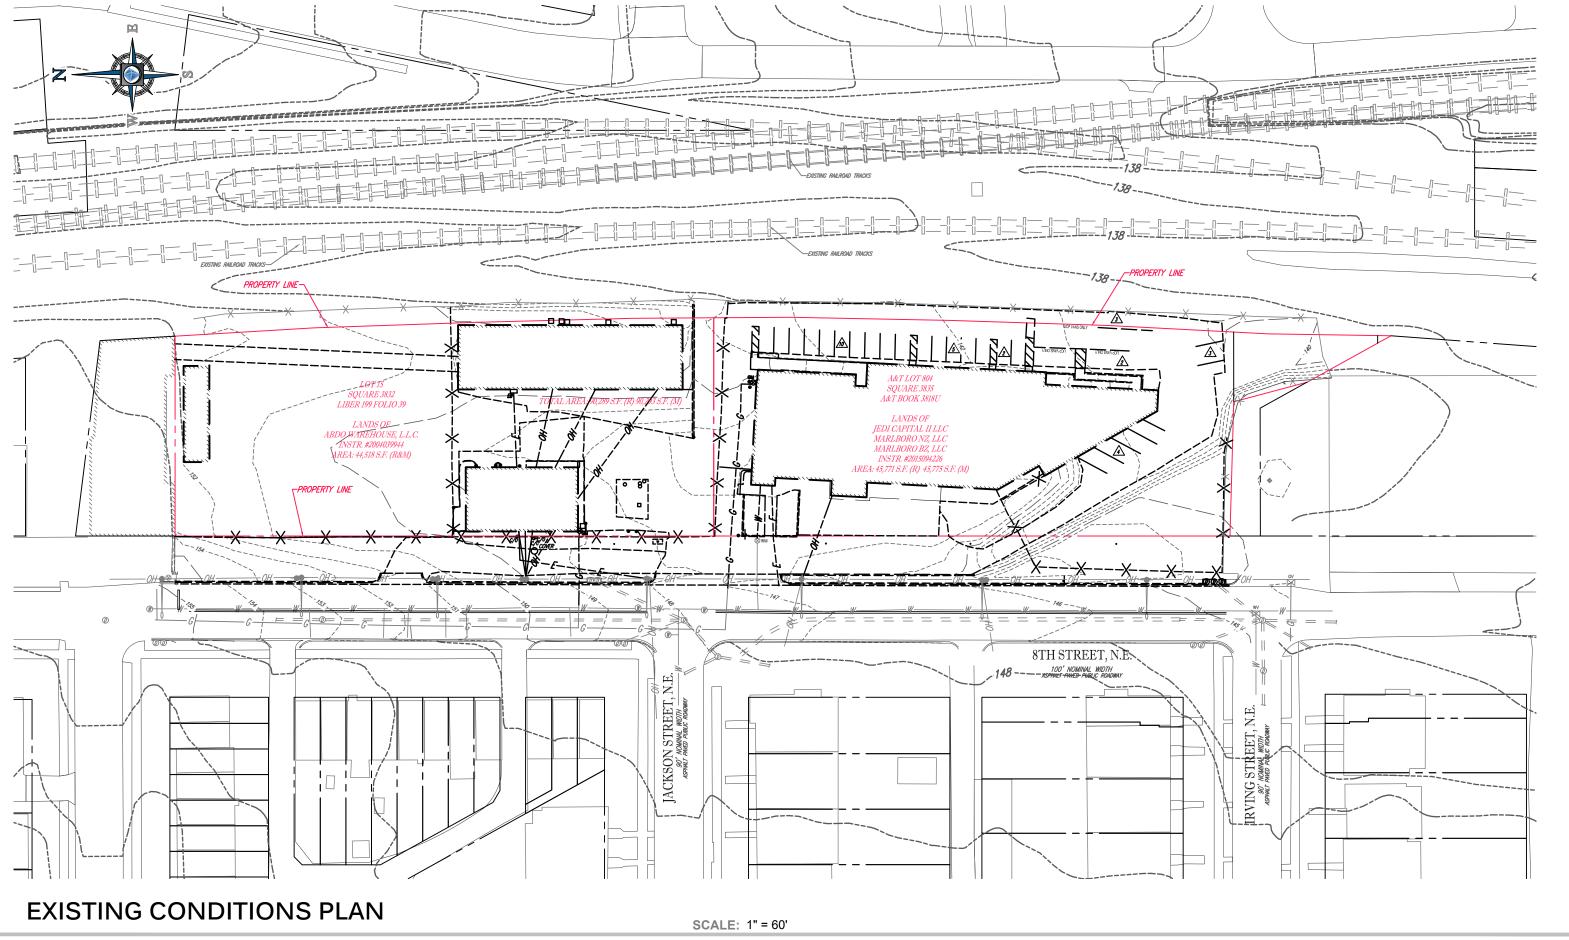




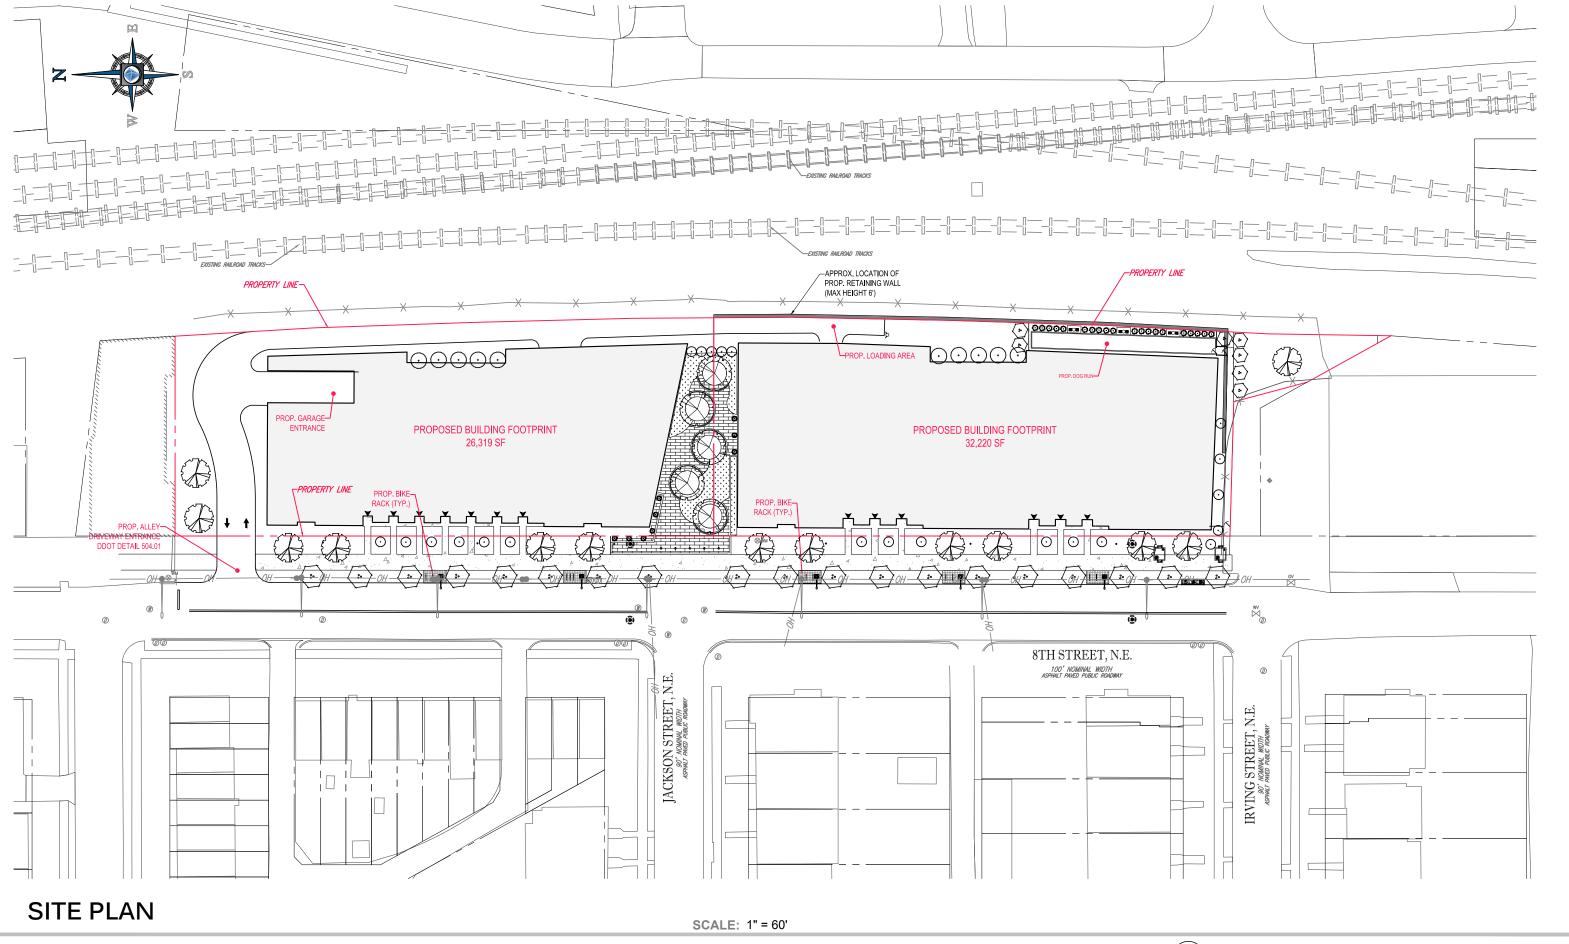




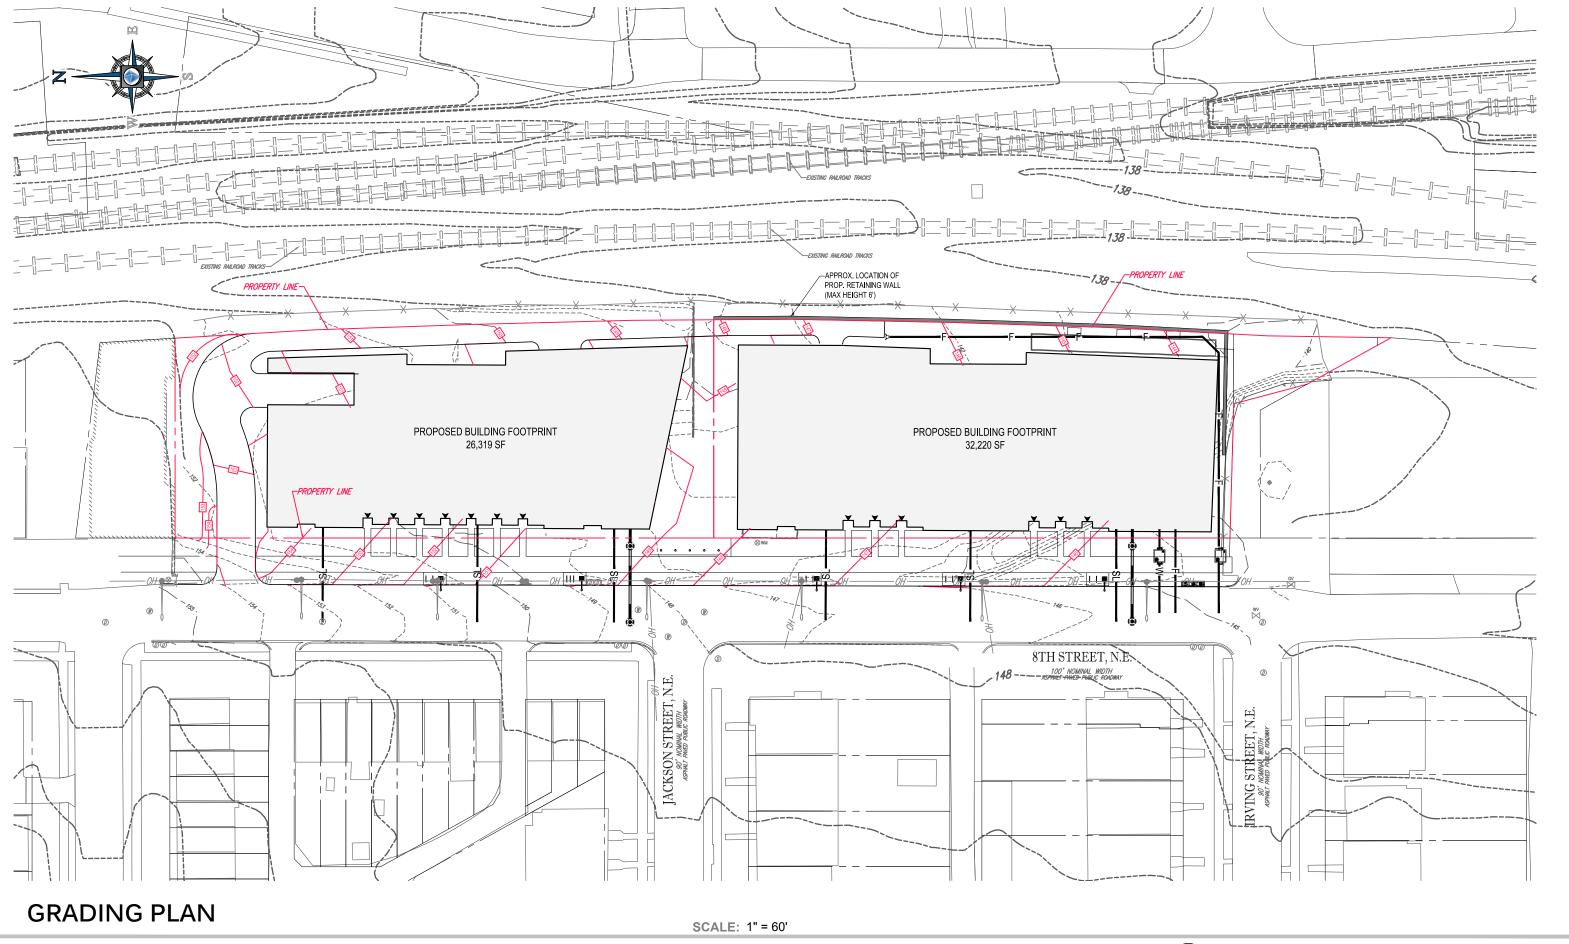




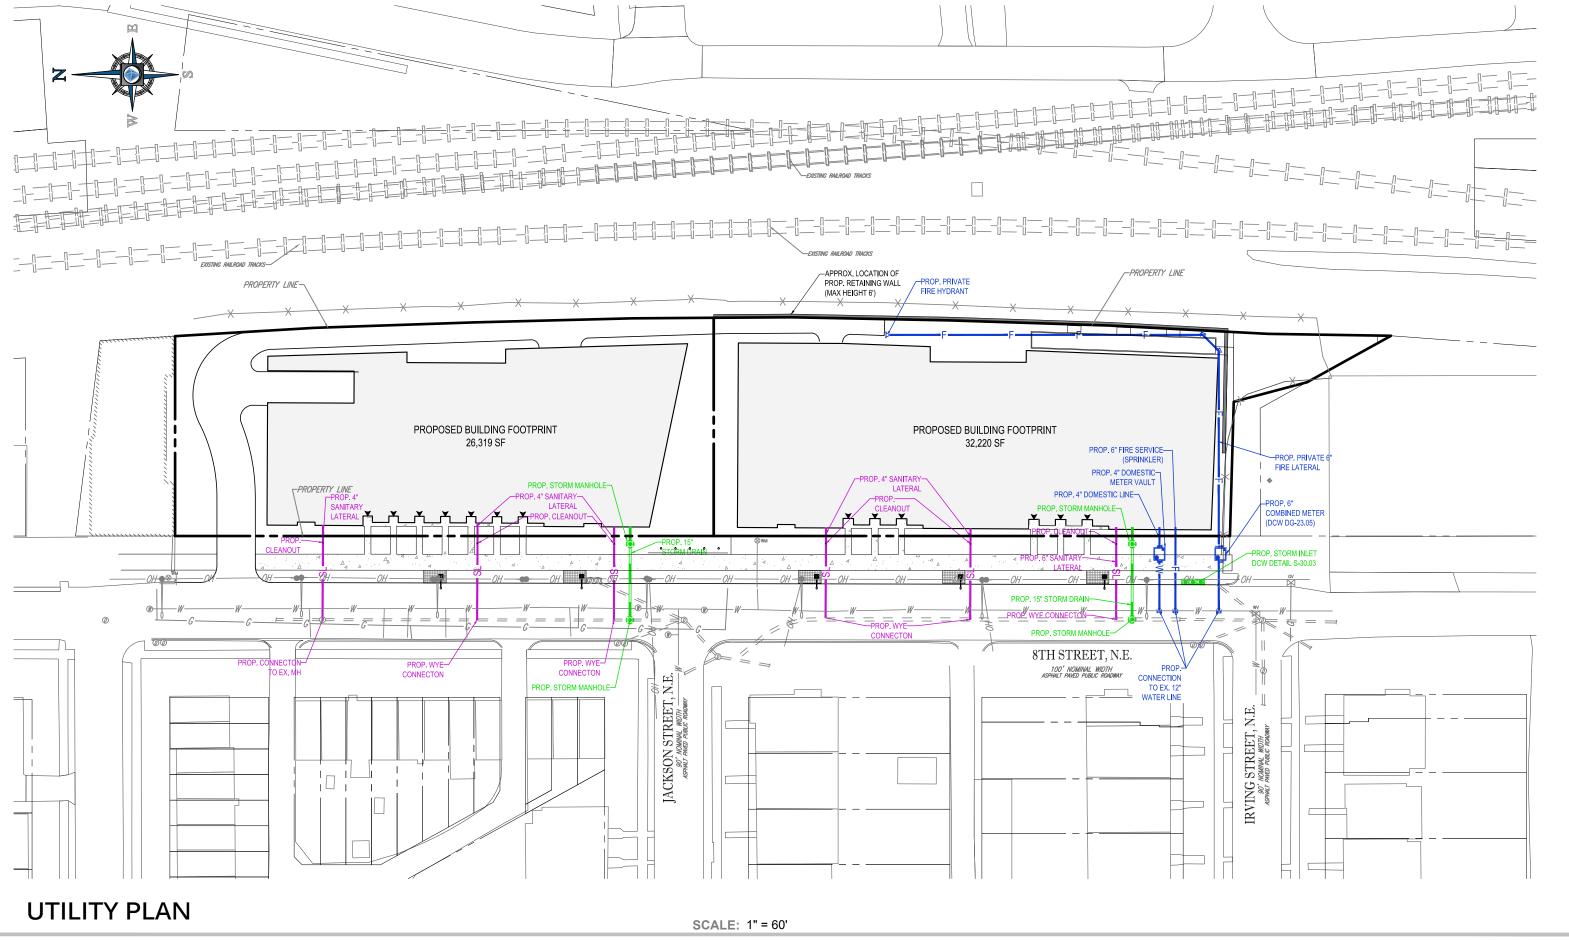





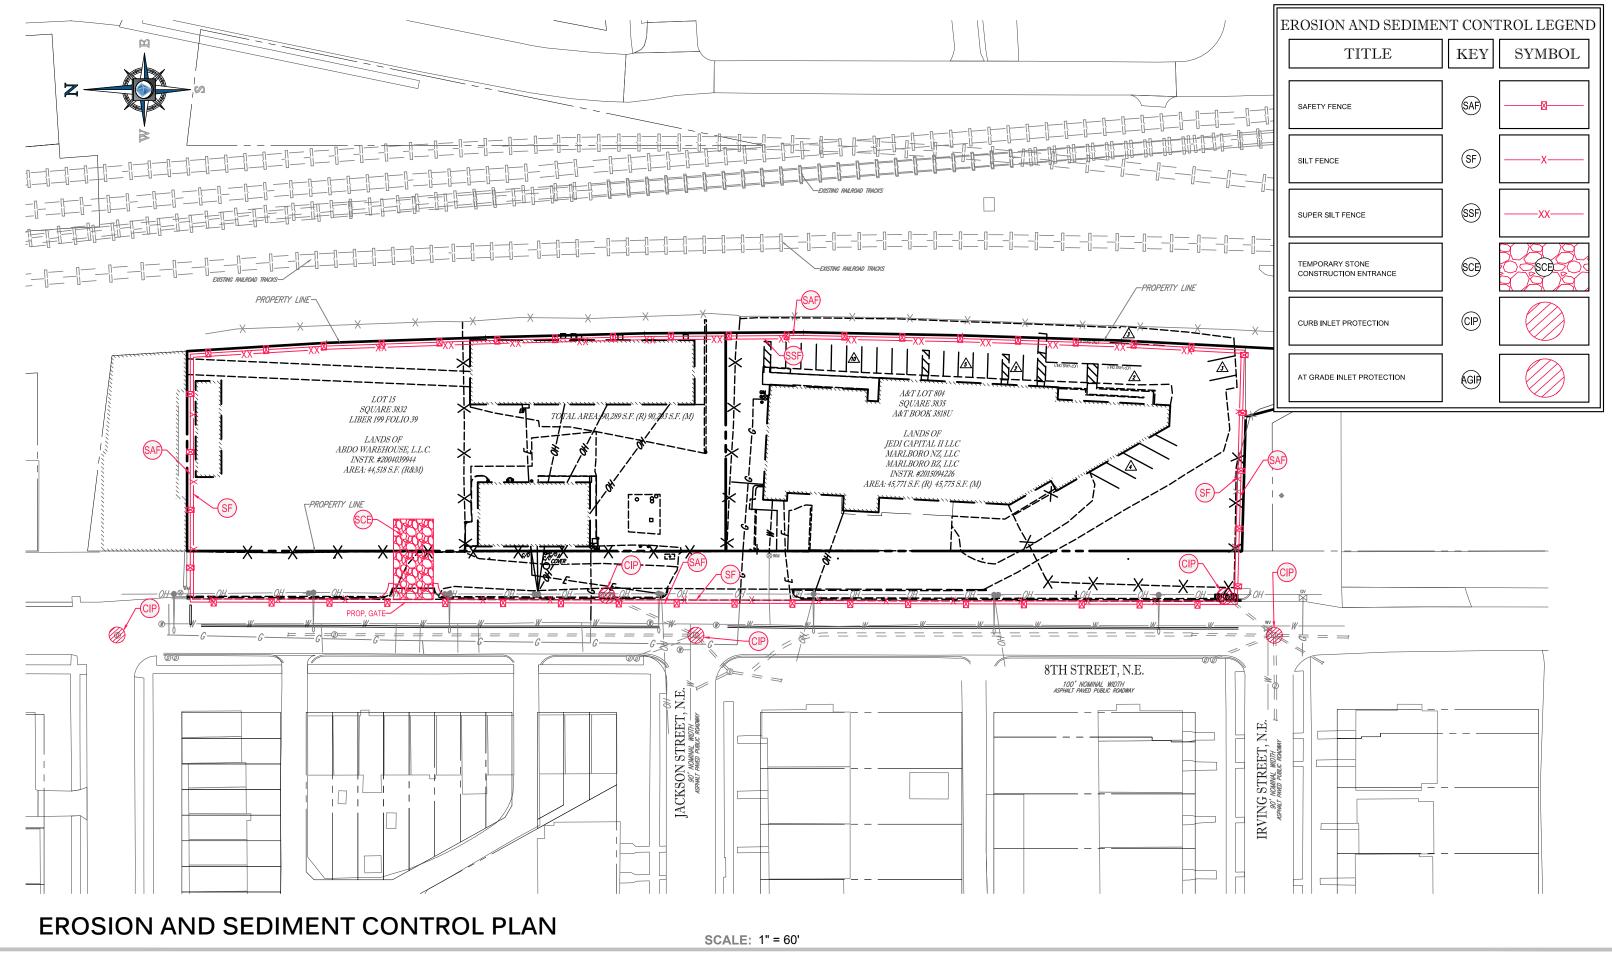





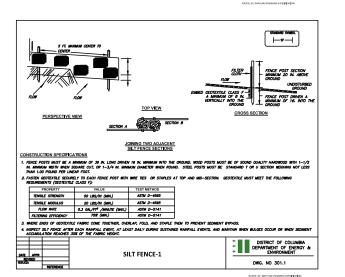


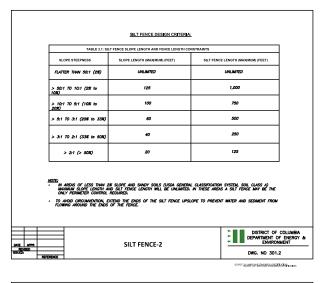


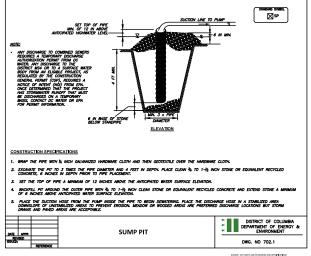


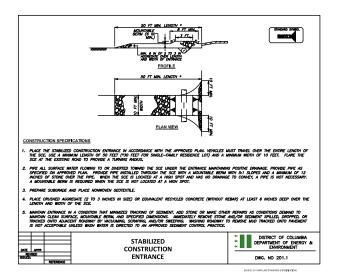


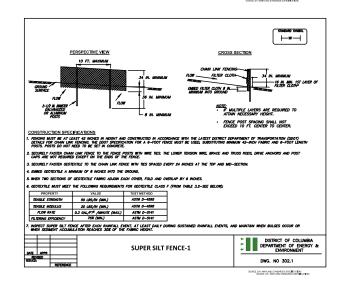


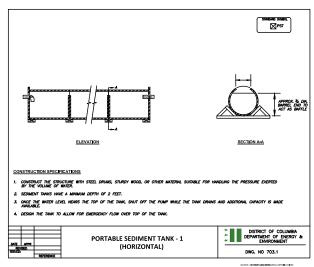

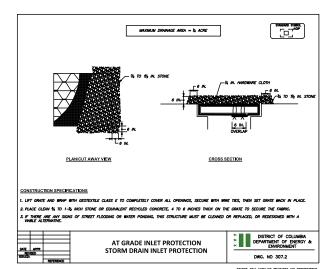

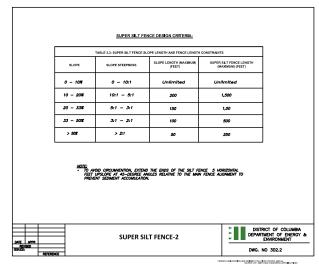

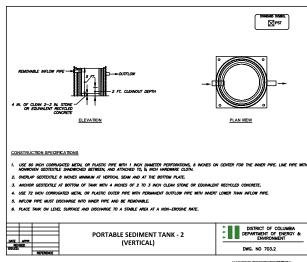


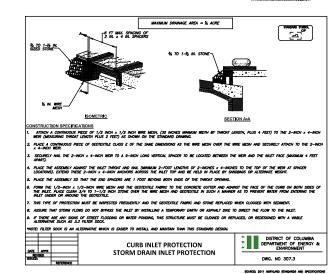

**EROSION AND SEDIMENT CONTROL NOTES AND DETAILS** 






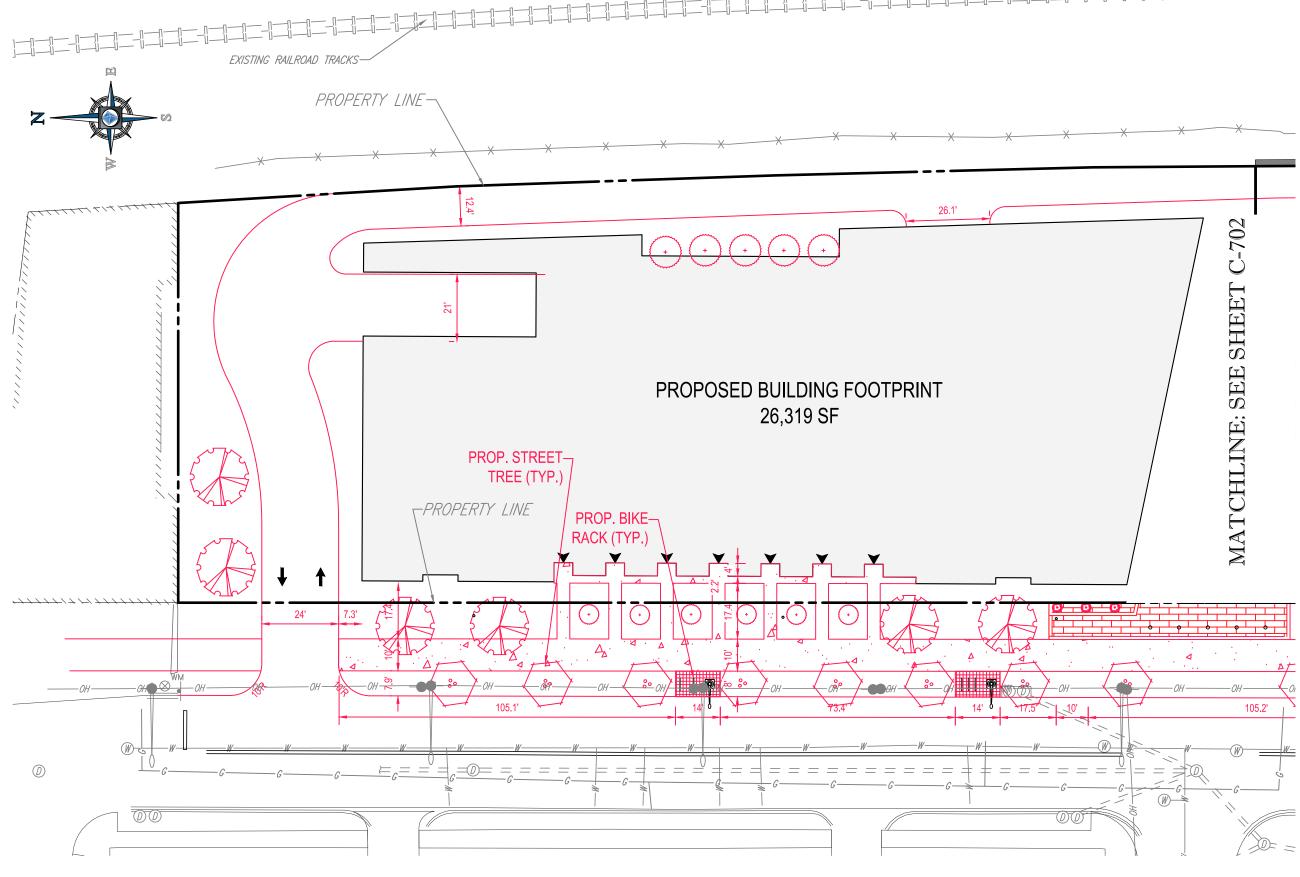

PUBLIC SPACE PLAN

SCALE: 1" = 30"




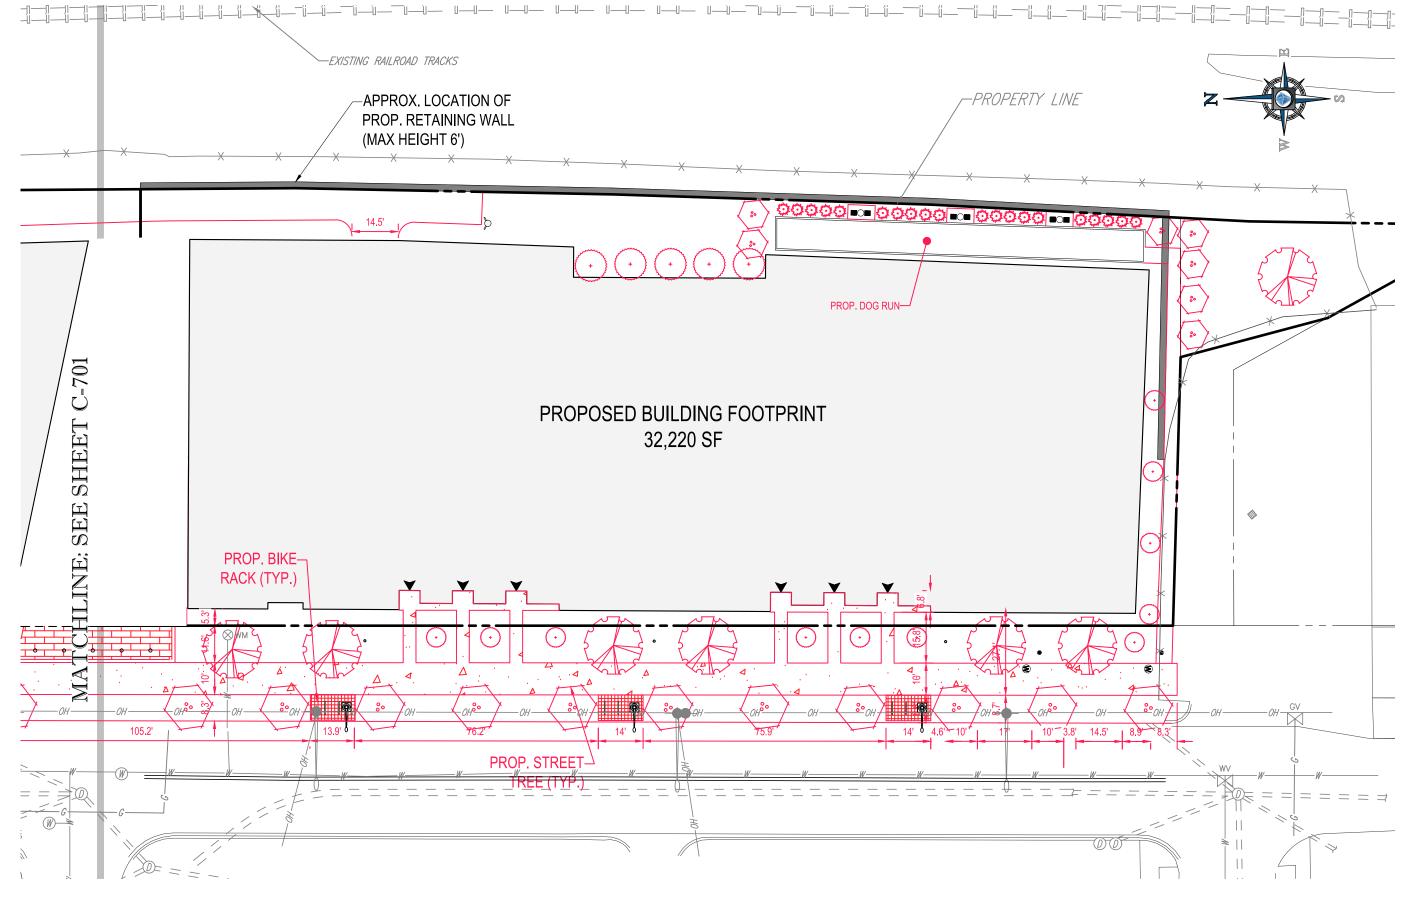

**PUBLIC SPACE PLAN** 

SCALE: 1" = 30"



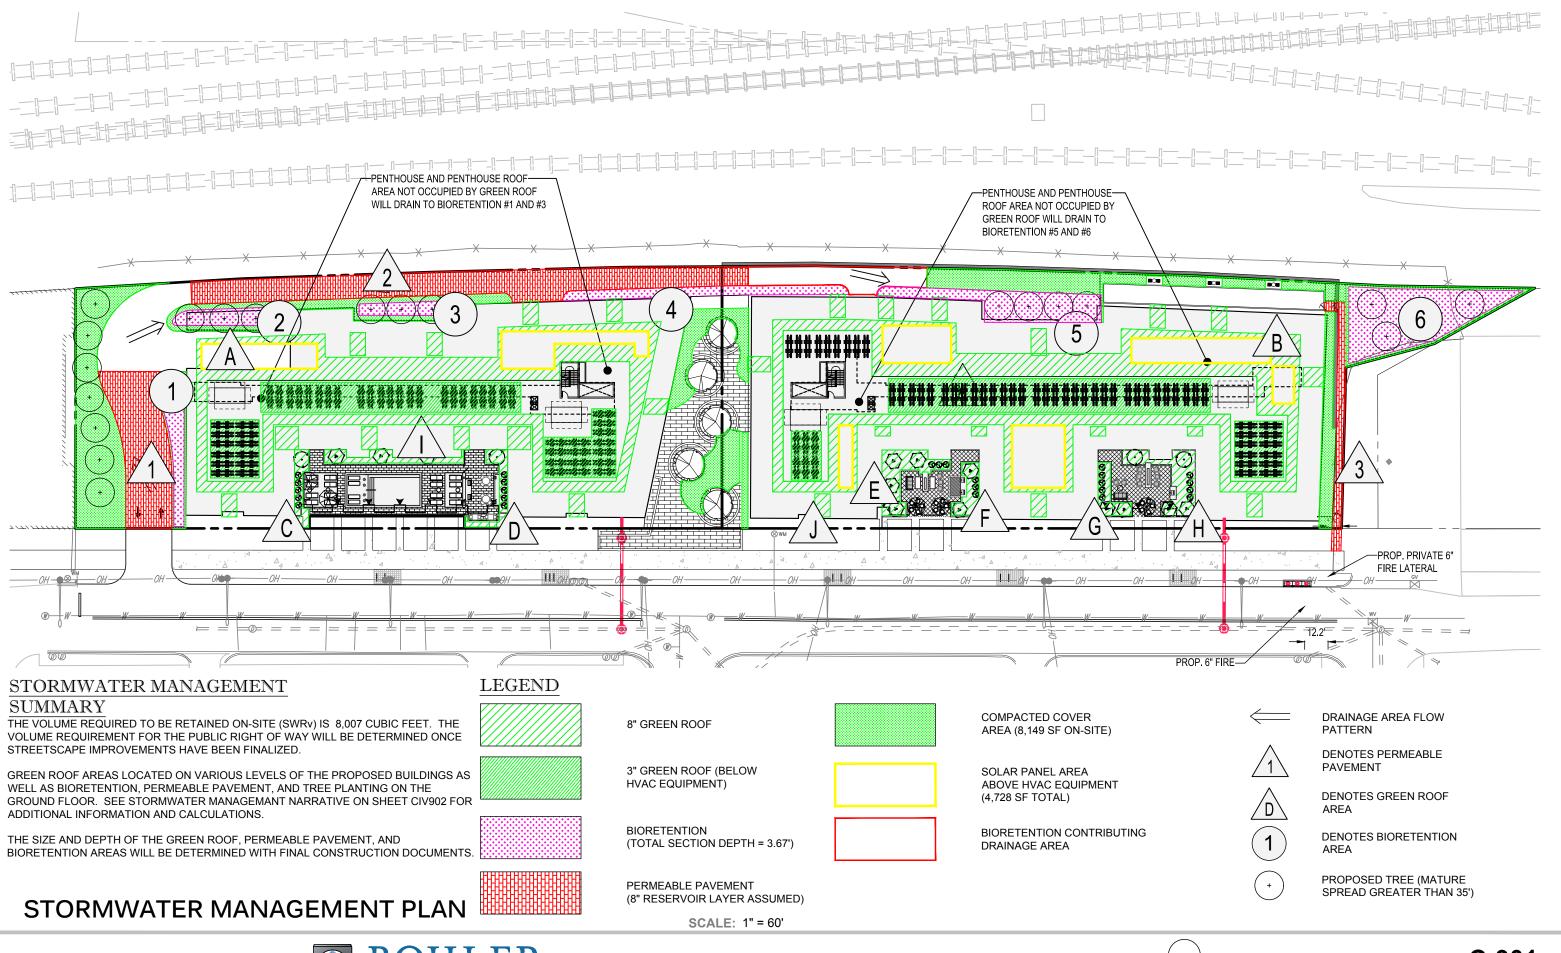



# GREEN ROOF TABLE:

					DRAINAGE					
	SURFACE	TOTAL	PROP. IMP	MEDIA DEPTH	LAYER		STORAGE			
GREEN ROOF#	AREA (SF)	CDA (SF)	(SF)	(in.)	DEPTH (IN)	LOCATION	PROVIDED	Max SWRv	SWRv PROVIDED	NOTES
Α	5,175	5,175	5,175	8	1		1617	696	696	
В	6,248	6,248	6,248	8	1		1953	841	841	
С	240	240	240	8	1		75	32	32	
D	278	278	278	8	1		87	37	37	
E	561	561	561	8	1		175	76	76	
F	255	255	255	8	1		80	34	34	
G	248	248	248	8	1		78	33	33	
Н	569	569	569	8	1		178	77	77	
I	363	363	363	8	1		113	49	49	
J	2,607	2,607	2,607	8	1		815	351	351	COMBO PENTHOUSE GR
К	7,952	7,952	7,952	3	1		994	1070	994	COMBO HVAC GR
						TOTAL	6,164	3,297	3,221	

		ME	DIA RETENTIO	N VALUE	0.4	45
	DF	RAINAGE LA	YER RETENTIO	N VALUE	0.:	15

# PERMEABLE PAVEMENT TABLE:

FACILITY	SA (SF)	SWRv (CF)	Storage (CF)	Gravel D(ft)
1	2,051	92	481	0.67
2	3,509	158	823	0.67
3	621	28	146	0.67
Total	6,181	278	1450	

# BIORETENTION TABLE:

	SURFACE	SURFACE											
	AREA,	AREA, TOP	TOTAL CDA	PROP. IMP	PROP. PERV		PONDING DEPTH	MEDIA DEPTH	GRAVEL DEPTH				
FACILITY	BOT. (SF)	(SF)	(SF)	(SF)	(SF)	FREEBOARD (FT)	(FT)	(FT)	(FT)	STORAGE PROVIDED	SWRv (CF)	Max SWRv	SWRv PROVIDED
1	642	642	8,346	7,523	181	0.25	0.5	1.5	1	819	491	1,105	491
2	523	523	3,999	2,921	555	0.25	0.5	1.5	1	667	400	483	400
3	406	406	8,484	7,523	555	0.25	0.5	1.5	1	518	311	1,087	311
4	735	735	5,866	3,523	1,608	0.25	0.5	1.5	1	937	562	630	562
5	1,247	1,247	9,851	8,604	0	0.25	0.5	1.5	1	1,590	954	1,326	954
6	2,097	2,097	18,169	11,398	4,674	0.25	0.5	1.5	1	2,674	1,604	1,982	1,604
									TOTAL	7,204	4,322	6,613	4,322

#### TREE PLANTING TABLE:

Activity	Trees	SWRv (CF)	Storage
tree planting (evergreen			
screening)	25	250	О

# STORMWATER MANAGEMENT CALCULATIONS AND DETAILS

SUMMARY

SWRv REQUIRED = 8,007 CF SWRv PROVIDED = 8,070 CF

STORAGE REQUIRED = 13,789 CF STORAGE PROVIDED = 14,817 CF

GAR REQUIRED = 0.3 GAR PROVIDED = 0.303

# PRELIMINARY GAR SCORECARD:

Green Area Ratio Scoresheet

		3832	3835	15, 804	Zone District MU-4	
	Other	67 / A 677 C A 71 A 667 C	CONTRACTOR AND ADDRESS OF THE PARTY.	Bed Vestinatelles state	and other participation of the state of the	
	Lot size (enter this value first) *	Lot area (sf) 90,293	Minimum Score  0.3	Multiplier SCORE:	GAR Score O. 30	
	Landscape Elements	30,233	Square Feet	Factor	10.5t	
_	11.0001 (t) 1.000 (final 3 yeshol) 7 (explored to yeshol) (t) 7903 (explored t) 500 (e. F.)	Positive at N	Square reec	I decer		
A	Landscaped areas (select one of the following for each	areaj	square feet			
1	Landscaped areas with a soil depth < 24"		square feet	0.30		
2	Landscaped areas with a soil depth $\geq 24^{\prime\prime}$		0 square feet	0.60		
3	Bioretention facilities		5,650	0.40	2,260	
В	Plantings (credit for plants in landscaped areas from S	ection A)	10007000014004	Native Bonus		
1	Groundcovers, or other plants < 2' height	7	square feet 8,149	5 square feet	1,629	
2	Plants≥2' height at maturity	# of plants	1 0	# of plants 0.30		
	- calculated at 9-sf per plant		4			
3	New trees with less than 40-foot can opy spread	# of trees	1250	# of trees 0.50	625	
,	- calculated at 50 sq ft per tree			5.35	023	
4	New trees with 40-foot or greater canopy spread	# of trees	1 .	# of trees		
0.00	- calculated at 250 sq ft per tree		0	0.80		
5	Preservation of existing tree 6" to 12" DBH	# of trees	1	# of trees		
3	- calculated at 250 sq ft per tree		0	0.70		
6		# of trees	T 22	# of trees		
O	Preservation of existing tree 12" to 18" DBH - calculated at 600 sq ft per tree		0	0.70		
-		# of trees	¥	# of trees		
7	Preservation of existing trees 18" to 24" DBH - calculated at 1300 sq ft per tree		0	0.70		
_	2 8	# of trees	<b>-</b> 7 29	# of trees		
8	Preservation of existing trees 24" DBH or greater - calculated at 2000 sq ft per tree		0	0.80		
200			square feet	square feet		
9	Vegetated wall, plantings on a vertical surface			0.60		
Ċ	Vegetated or "green" roofs		988	*		
1	Over at least 2" and less than 8" of growth medium		square feet 7,952	square feet 0.60	4,771	
			square feet	squore feet		
2	Over at least 8" of growth medium		16,544	0.80	13,235	
D	Permeable Paving***					
1	Permeable paving over 6" to 24" of soil or gravel		square feet 6, 181	0.40	2,472	
			square feet			
2	Permeable paving over at least 24" of soil or grave			0.50		
E	Other					
1	Enhanced tree growth systems***		square feet	0.40		
			square feet			
2	Renewable energy generation		4,728 square feet	0.50	2,364	
3	Approved water features			0.20		
E	Bonuses	sub-tatal of sq ft :	50,454			
1	Native plant species		square feet O	0.10		
	10 00		square feet			
2	Landscaping in food cultivation		square feet	0.10	-	
3	Harvested stormwater irrigation			0.10	(14)	
Perm	neable paving and structural soil together may not qualify for more than one	third of the Green A	Green Areo Rotio n rea Ratio score.	umerator =	27,3	

SCALE: 1" = 60'



